ECS Building

Port Ewen, NY2012 - present

1830 sf before --> 1830 sf renovated

Scope of work:

Owner GC - c.1840s timber frame with fire damage - complete renovation to office and showroom

Insulation/Envelope: closed-cell spray foam insulation on basement ceiling (3" = R-18 min.), in walls (4" = R-24 min.), and in rafters (3" = R-36 min.) with (2) layers of 1 1/2" rigid insulation over walls (3" = R-15 min.) and (2) layers of 3" rigid insulation with taped, staggered joints over rafters (6" = R-30 min.), triple pane windows

HVAC: Heat Recovery Ventilator, air-source heat pump

Solar: 7+ kW system - actual output to be determined (future)

Builder: Energy Conservation Specialists, LLC - Bill McKnight



Google earth























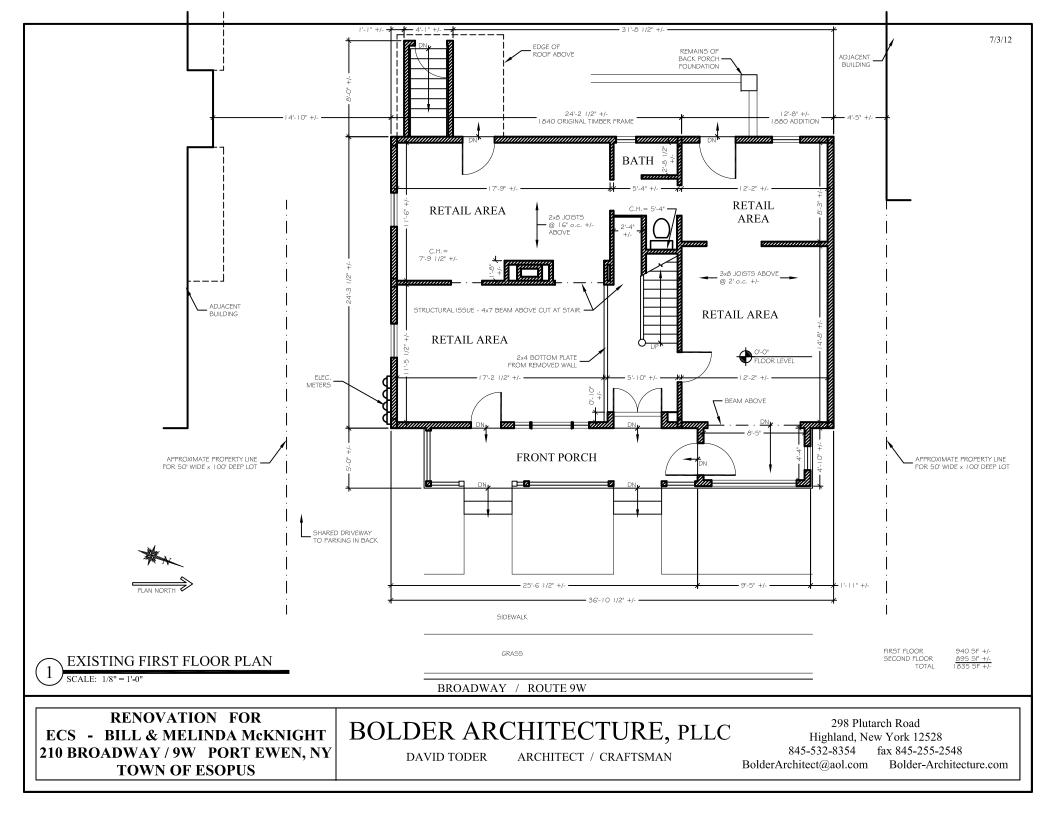

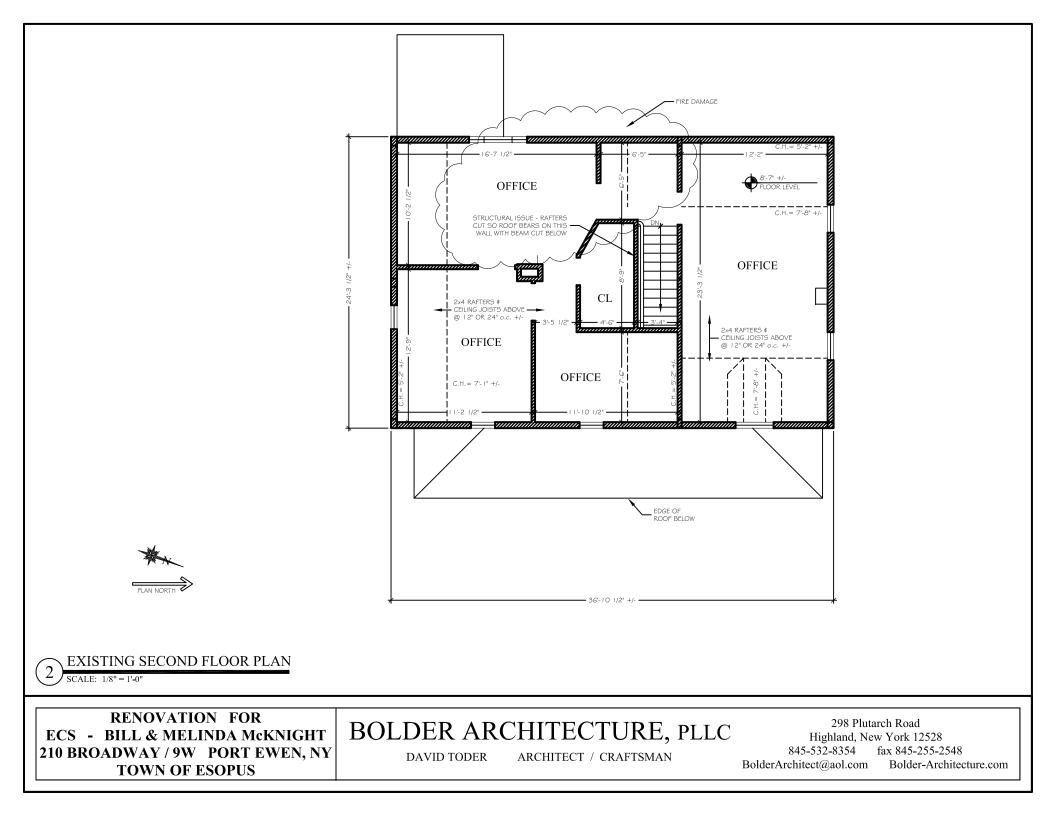


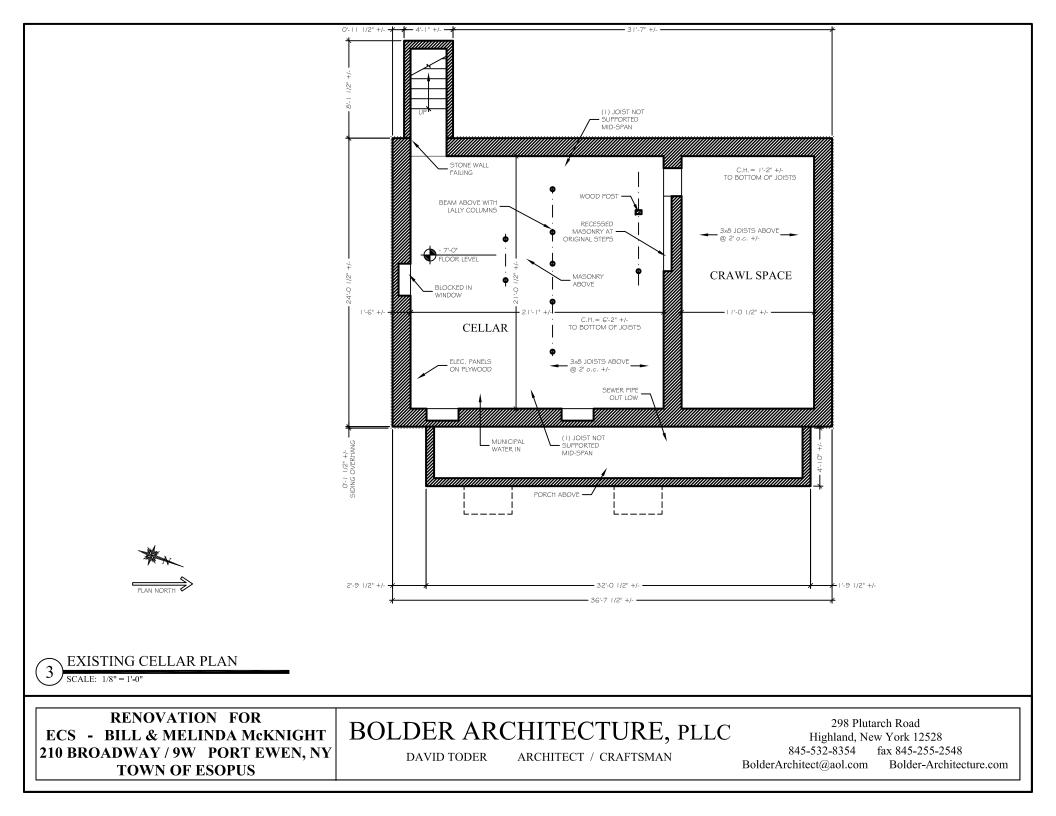



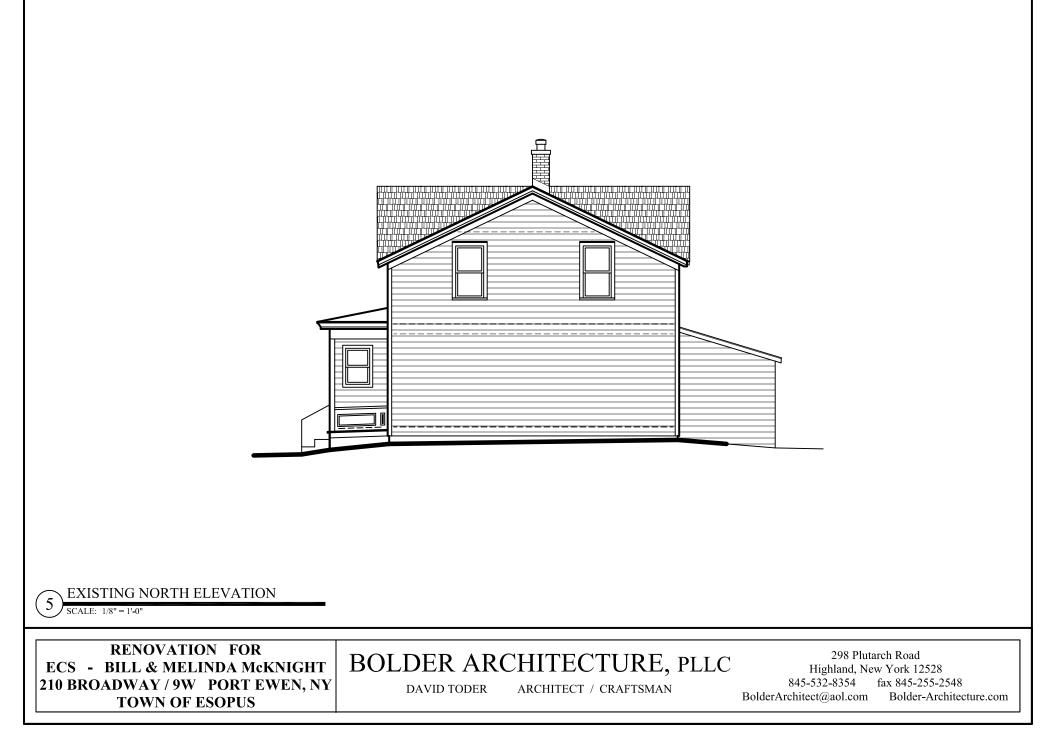



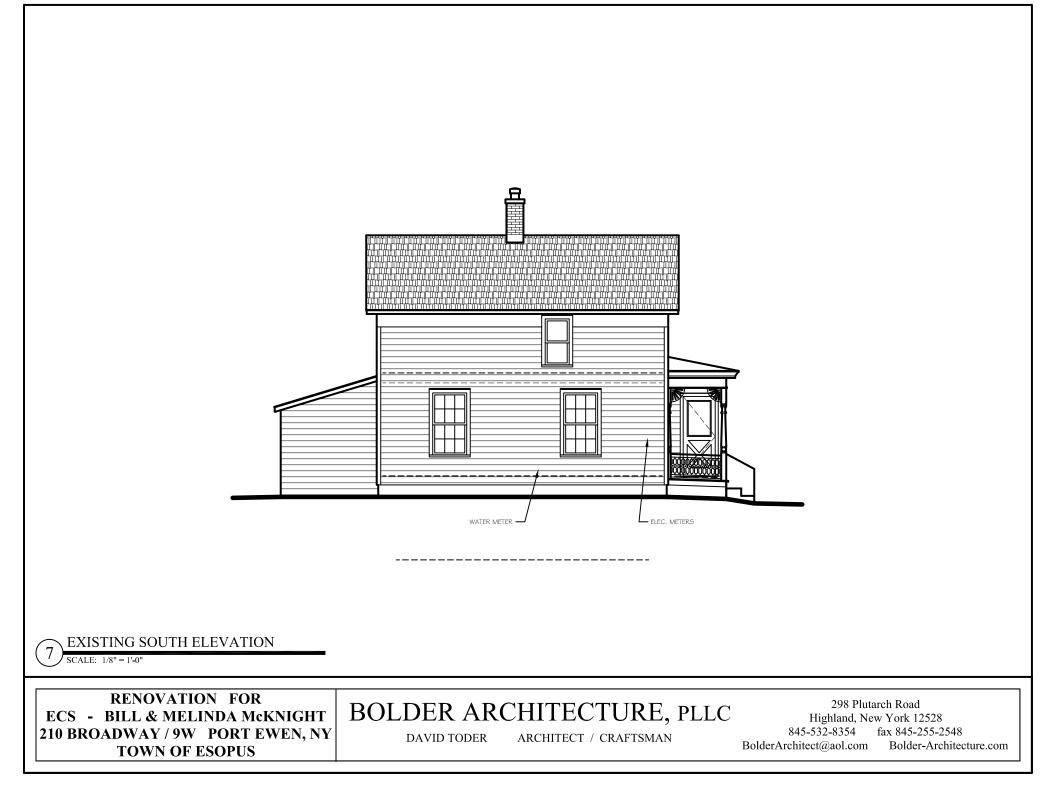

- Bill &

COMMER Energy Conse

210 Broa Port Ewen, New


ABBREVIATIONS & SYMBOLS

A.F.F. ABOVE FINISH FLOOR ALUM ALUMINUM AMP AMPERE APPROX. APPROXIMATELY C.H. C.I.P. CEILING HEIGHT CAST IN PLACE - DRAWING NUMBER CLOSET CL. СМИ CONCRETE MASONRY UNIT CONC. CONCRETE CT CERAMIC TILE SHEET NUMBER DF DOUGLAS FIR DN DOWN BUILDING SECTION KEY D.W. ELEC DISHWASHER ARROW INDICATES DIRECTION OF VIEW ELECTRIC / ELECTRICAL ELEV ELEVATION EQ. EQUAL EXG EXISTING ICF INSULATED CONCRETE FORM FL FLOOR FEET FT - DRAWING NUMBER GALV. GALVANIZED - SHEET NUMBER A05 GWB GYPSUM WALL BOARD - SHEETROCK ΗB HOSE BIB - FROST FREE ∖ AO4 / НM HOLLOW METAL HRV DETAIL SECTION KEYS HEAT RECOVERY VENTILATOR ARROW INDICATES DIRECTION OF VIEW ICFs INSULATED CONCRETE FORMS INSUL INSULATION INT. ELEV. INTERIOR ELEVATION LAMINATED VENEER LUMBER LVL MARB MARBLE MAX. MAXIMUM ----- DRAWING NUMBER MECH. MECHANICAL MIL — SHEET NUMBER MILLIMETER MIN. MINIMUM M.O. MASONRY OPENING MR GWB MOISTURE RESISTANT GYPSUM WALL BOARD INTERIOR ELEVATION KEY N.I.C. NOT IN CONTRACT ARROWS INDICATE DIRECTION OF VIEW N.T.S. NOT TO SCALE O.C. ON CENTER OSB ORIENTED STRAND BOARD PLY PLYWOOD POLY POLYURETHANE DOOR KEY P.O.S. POINT OF SUPPORT 202 PREP PREPARE PSF POUNDS PER SQUARE FOOT PSI (A)POUNDS PER SQUARE INCH WINDOW KEY ΡT PRESSURE TREATED REQ. REQUIRED R.O. ROUGH OPENING R.O.B. RUN OF BANK 201 ROOM NUMBER SF SQUARE FEET SPF SPRUCE-PINE-FIR TBD TO BE DETERMINED TŧG KEYED NOTE TONGUE & GROOVE THRU THROUGH TYP TYPICAL VCB VINYL COVE BASE VSF VINYL SHEET FLOORING V.I.F. VERIFY IN FIELD W/ WITH WD WOOD W.W.M. WOVEN WIRE MESH NOTE:

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LEGEND MAY INCLUDE ABBREVIATIONS & SYMBOLS NOT USED IN THIS PROJECT.


IERCIAL REI for onservation S & Melinda M Broadway /	COMMERCIAL RENOVATION FOR ENERGY CONSERVATION SPECIALISTS, LLC BILL & MELINDA McKNIGHT 210 BROADWAY / ROUTE 9W PORT EWEN, NY 12466 TOWN OF ESOPUS MILL & MELINDA MCKNIGHT MILL & MELINDA MCKNIGHT VIDATION OF THE LWY FOR ANY PESSON TO ALTER MICHANICON OF THE LWY FOR ANY PESSON TO ALTER MICHANICON MORTON MELINE NY THESE SOLUTIONS WITH THE SEA OF A UCENSED ARCHITET.	
ENERGY CONSERVATION	6 Town of Esopus Climate & Geographic Design Criteria	
THE EXISTING BUILDING RENOVATION DESCRIBED IN THESE DRAWINGS COMPLIES WITH ALL APPLICABLE REQUIREMENTS OF THE 2010 ENERGY CONSERVATION CONSTRUCTION CODE CHAPTER 5 FOR COMMERCIAL ENERGY EFFICIENCY AS SPECIFIED IN TABLE 502.2(1) BUILDING ENVELOPE REQUIREMENTS - OPAQUE ASSEMBLIES & TABLE 502.3 BUILDING ENVELOPE REQUIREMENTS: FENESTRATION FOR CLIMATE ZONE 6. ROOFS R-VALUE ROOFS R-VALUE ROOFS R-VALUE ROOFS R-VALUE ROOFS R-VALUE REQUIRED NOOD FRAME WALL R-VALUE RLOOR R-VALUE ROOFS R-VALUE RED R-38 MIN. FLOOR R-VALUE ROOFS R-VALUE RED R-38 MIN. FLOOR R-VALUE R-VALUE R-30 MIN. FENESTRATION U-FACTOR O.35 MAX. O.35 MAX.	GROUND SNOW LOADWIND SPEEDSEISMIC DESIGN CATEGORYSUBJECT TO DAMAGE FROM TESIGN CATEGORYICE SHIIELD UNDERLAMMENT REQUIREDICE SHIIELD UNDERLAMMENT REQUIREDFLOOD HAZARDS40 PSF90 MPHBSEVERE48 INMODERATE TO HEAVYR905.2.7.1.	
DRAWING LIST	SITE PLAN	
 TO I TITLE SHEET A0 I FIRST FLOOR PLAN, WINDOW SCHEDULE & DETAILED WALL SECTION A02 SECOND FLOOR, CELLAR & ROOF PLANS & ROOF BRACKET DETAIL A03 ELEVATIONS 	THIS SITE PLAN, BASED ON THE DEED DESCRIPTION \$ FIELD MEASUREMENTS BY DAVID TODER, RA, OF BOLDER ARCHITECTURE, PLLC, OF NEW PALTZ, NY, DATED JUNE 5, 2012, IS SCHEMATIC IN NATURE AND IS NOT INTENDED FOR USE AS A FORMAL SURVEY. 6500 SF ~ 0.15 +/- ACRES SBL# 56.67-5-10 APPROXIMATE PROPERTY LINE	
	EXISTING SHARED GRAVEL DRIVEWAY TO PARKING AREA NEW DECK # EXISTING BUILDING PROPERTY LINE	BOLDER ARCHITECTURE PLLC DAVID TODER ARCHITECT / CRAFTSMAN
 DO NOT SCALE DRAWINGS. ALL MATERIALS AND METHODS OF CONSTRUCTION NOT SPECIFICALLY ADDRESSED IN THESE DRAWINGS AND SPECIFICATIONS SHALL COMPLY WITH THE MINIMUM CURRENT STANDARDS OF THE RESIDENTIAL CODE OF NEW YORK STATE, THE NYS ENERGY CONSERVATION CODE, THE TOWN OF ESOPUS, THE ULSTER COUNTY DEPARTMENT OF HEALTH AND THE NYS BOARD OF FIRE UNDERWRITERS. CONTRACTOR IS RESPONSIBLE FOR THE REMOVAL FROM THE SITE OF ALL CONSTRUCTION DEBRIS. 	14'-10" +/- U U U U U U U U U U U U U U U U U U U	LEED AP 298 Plutarch Road Highland, New York 12528 Town of New Paltz 845-532-8354 fax 845-255-2548 BolderArchitect@aol.com Bolder-Architecture.com PROJECT # 12-24 DATE: 9/12/12 TTTLE SHEET

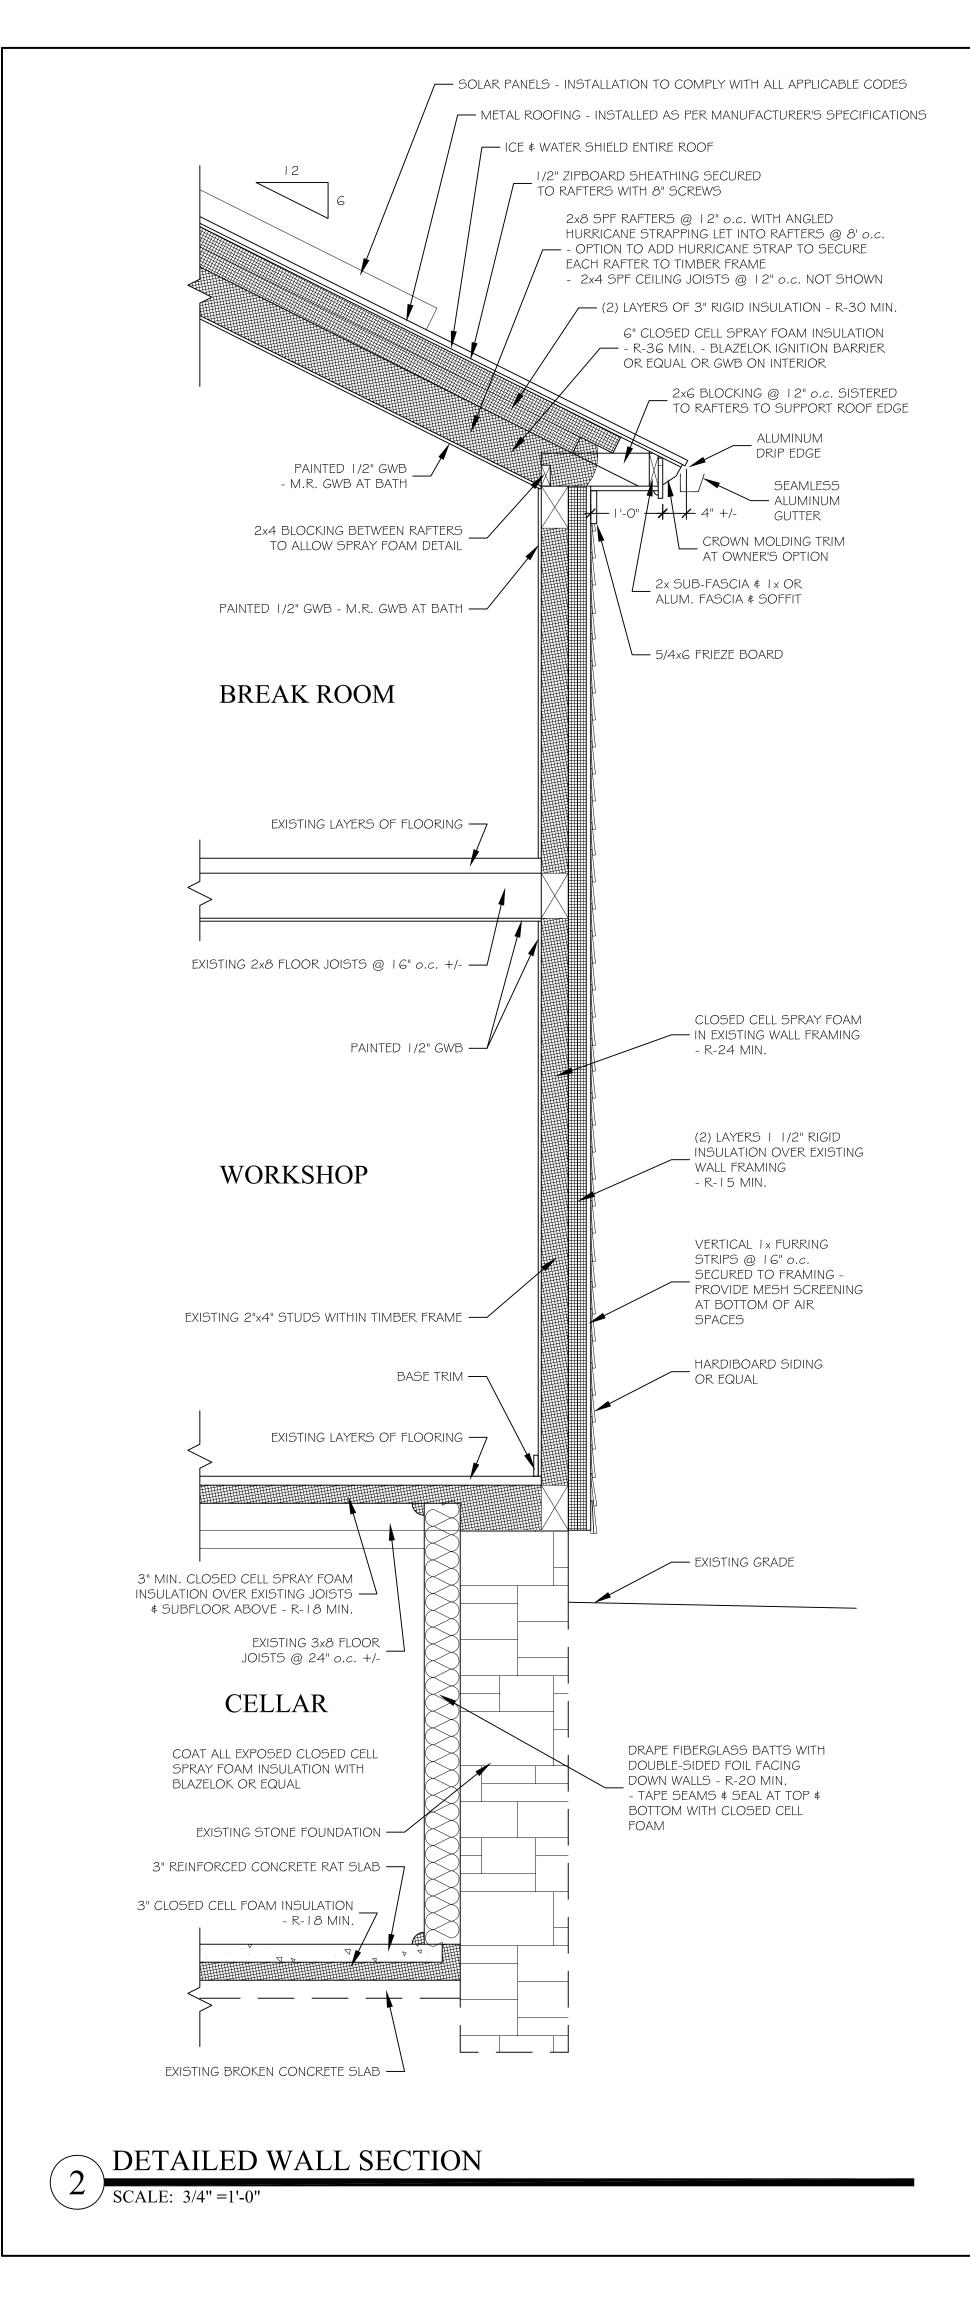

BROADWAY / ROUTE 9W

SCALE: $1/4'' = 1' - \overline{0''}$



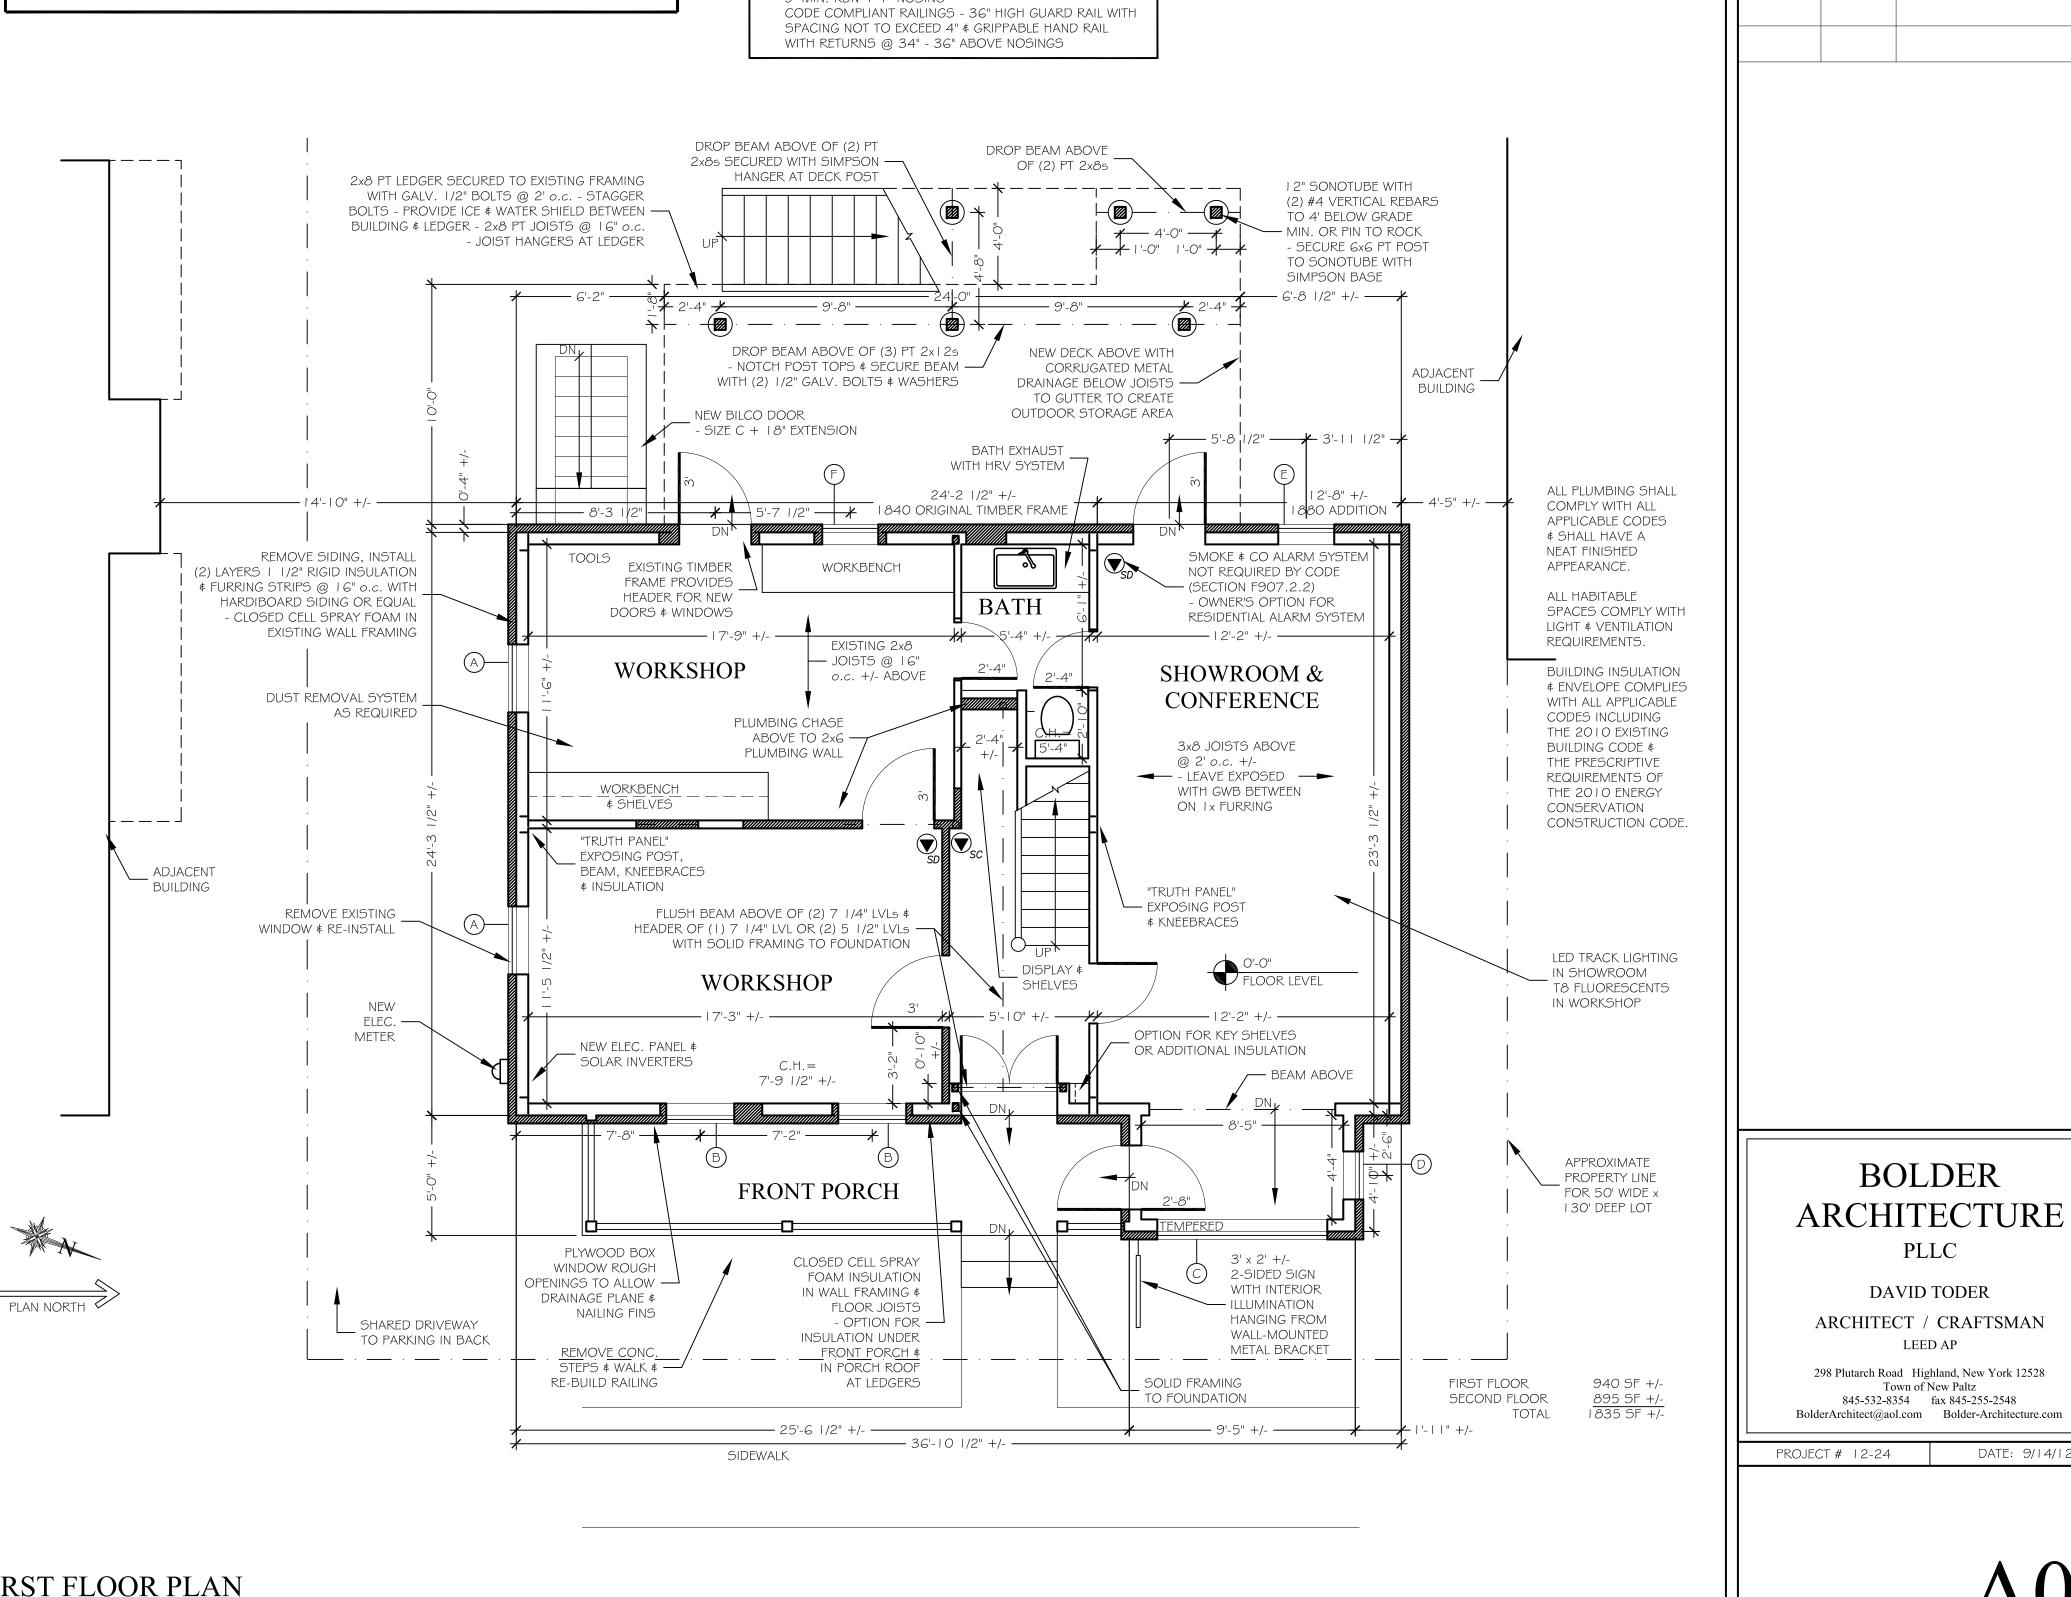

W	INDOW	SCHEDULE	
WINDOW TYPE	ROUGH OPENING W x H	NOTES	# OF UNITS
A	2'-10" x 5'-2" +/-	DOUBLE HUNG - EXISTING RE-INSTALLED	2
В	2'-10" x 5'-2" +/-	DOUBLE HUNG - NEW TO MATCH EXISTING	2
С	7' x 5' +/-	FIXED - TEMPERED	1
D	2' x 3'-8" +/-	DOUBLE HUNG	1
E	2'-4" x 3'-8" +/-	DOUBLE HUNG	1
F	2'-4" x 3'-8" +/-	CASEMENT	1
G	2' x 3'-6" +/-	DOUBLE HUNG	2
Н	3'-2" x 3'-4" +/-	DOUBLE HUNG PAIR	1
J	2'-4" x 4'-4" +/-	DOUBLE HUNG	2
K	4' x 4'-8" +/-	CASEMENT PAIR - EGRESS	1
GENERAL	NOTES		
I. WINDOW UNITS TO BE MANUFACTURED BY EARTHWISE WINDOWS & DOORS OR EQUAL, ALL VINYL WITH TRIPLE PANE Low E INSULATING GLASS (U-VALUE = 0.32 MAX.) & MUNTINS AS SHOWN, UNLESS OTHERWISE NOTED. OPERATING UNITS TO HAVE INSECT SCREENS. REFER TO ELEVATIONS ON SHEET AO3.			
2. WINDOW	TYPE "I" NOT USED FOR CLA	RITY. CONFIRM SIZES & SPECIFICATIONS PRIOR TO OR	DERING.

GENERAL NOTES

- A. ALL NEW EXTERIOR WALL FRAMING TO MATCH EXISTING 2x4" +/- @ 16" o.c. WITH EXTERIOR INSULATION AS NOTED. ALL INTERIOR WALLS TO BE 2x4 SPF STUDS @ I 6" O.C. UNLESS OTHERWISE NOTED.
- 3. DIMENSIONS ARE FROM FRAMING TO FRAMING. ALL FRAMING SPF UNLESS OTHERWISE NOTED.
- . PROVIDE CODE COMPLIANT BLOCKING AS REQUIRED SUCH AS RIM JOISTS OR 2x BLOCKING AT JOIST BEARING POINTS, RIDGE BOARD & BLOCKING AT RAFTER BEARING POINTS, ∉ @ 10' o.c. MAX. AT STUDS.
- PROVIDE GWB BLOCKING AT EXTERIOR WALL CORNERS \$ INTERSECTIONS THAT ALLOWS INSULATION - EnergyStar
- PROVIDE HVAC SYSTEM AS REQUIRED WITH HEAT RECOVERY VENTILATION SYSTEM (LIFEBREATH OR EQUAL) THAT INCLUDES BATH EXHAUST. SEAL DUCT SYSTEM TO EnergyStar STANDARDS. SEAL ALL BUILDING ENVELOPE PENETRATIONS WITH THE APPROPRIATE TYPE OF CAULK OR EXPANDING FOAM INSULATION.
- . CENTER CLOSET DOORS UNLESS OTHERWISE NOTED.
- G. SMOKE & CO DETECTORS SHOWN ON FLOOR PLANS.
- 1. CODE COMPLIANT STAIRS 8 1/4" MAX. RISE \$ 9" MIN. RUN + 1" NOSING

ELEC. EQUIPMENT LEGEND

SYMBOL

DESCRIPTION

COMBINATION SMOKE & CARBON MONOXIDE DETECTOR - INTERCONNECTED WITH ALL OTHER 6MOKE & CARBON MONOXIDE DETECTORS SMOKE DETECTOR - INTERCONNECTED WITH ALL OTHER SMOKE & CARBON MONOXIDE DETECTORS

ELECTRICAL NOTES

- A. ELECTRICAL WORK TO COMPLY WITH ALL APPLICABLE CODES & REGULATIONS.
- B. COVERPLATES TO BE WHITE.
- C. ALL LIGHTS IN CLOSETS TO HAVE ENCLOSED GLOBE FIXTURES.
- D. PROVIDE ELEC. SUPPLY AS REQUIRED TO ALL FIXTURES, APPLIANCES & MECHANICAL UNITS.

COMMERCIAL RENOVATION FOR

ENERGY CONSERVATION SPECIALISTS, LLC

BILL & MELINDA McKNIGHT

210 BROADWAY / ROUTE 9W PORT EWEN, NY 12466


TOWN OF ESOPUS


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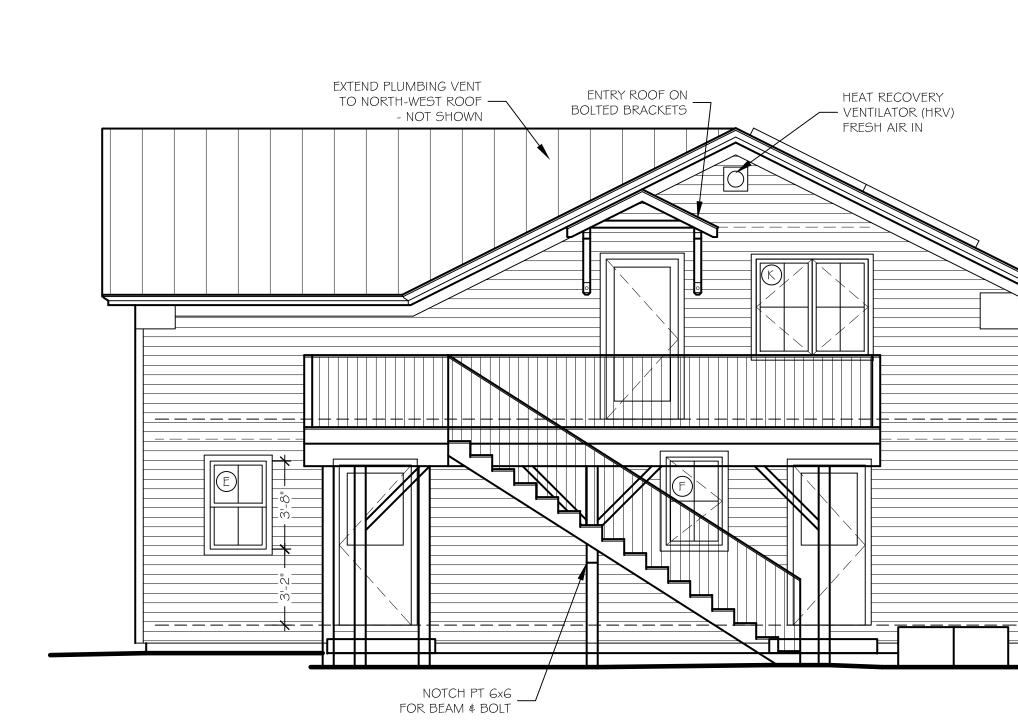
DATE: 9/14/12


FLOOR PLANS


REVISION DATE DESCRIPTION



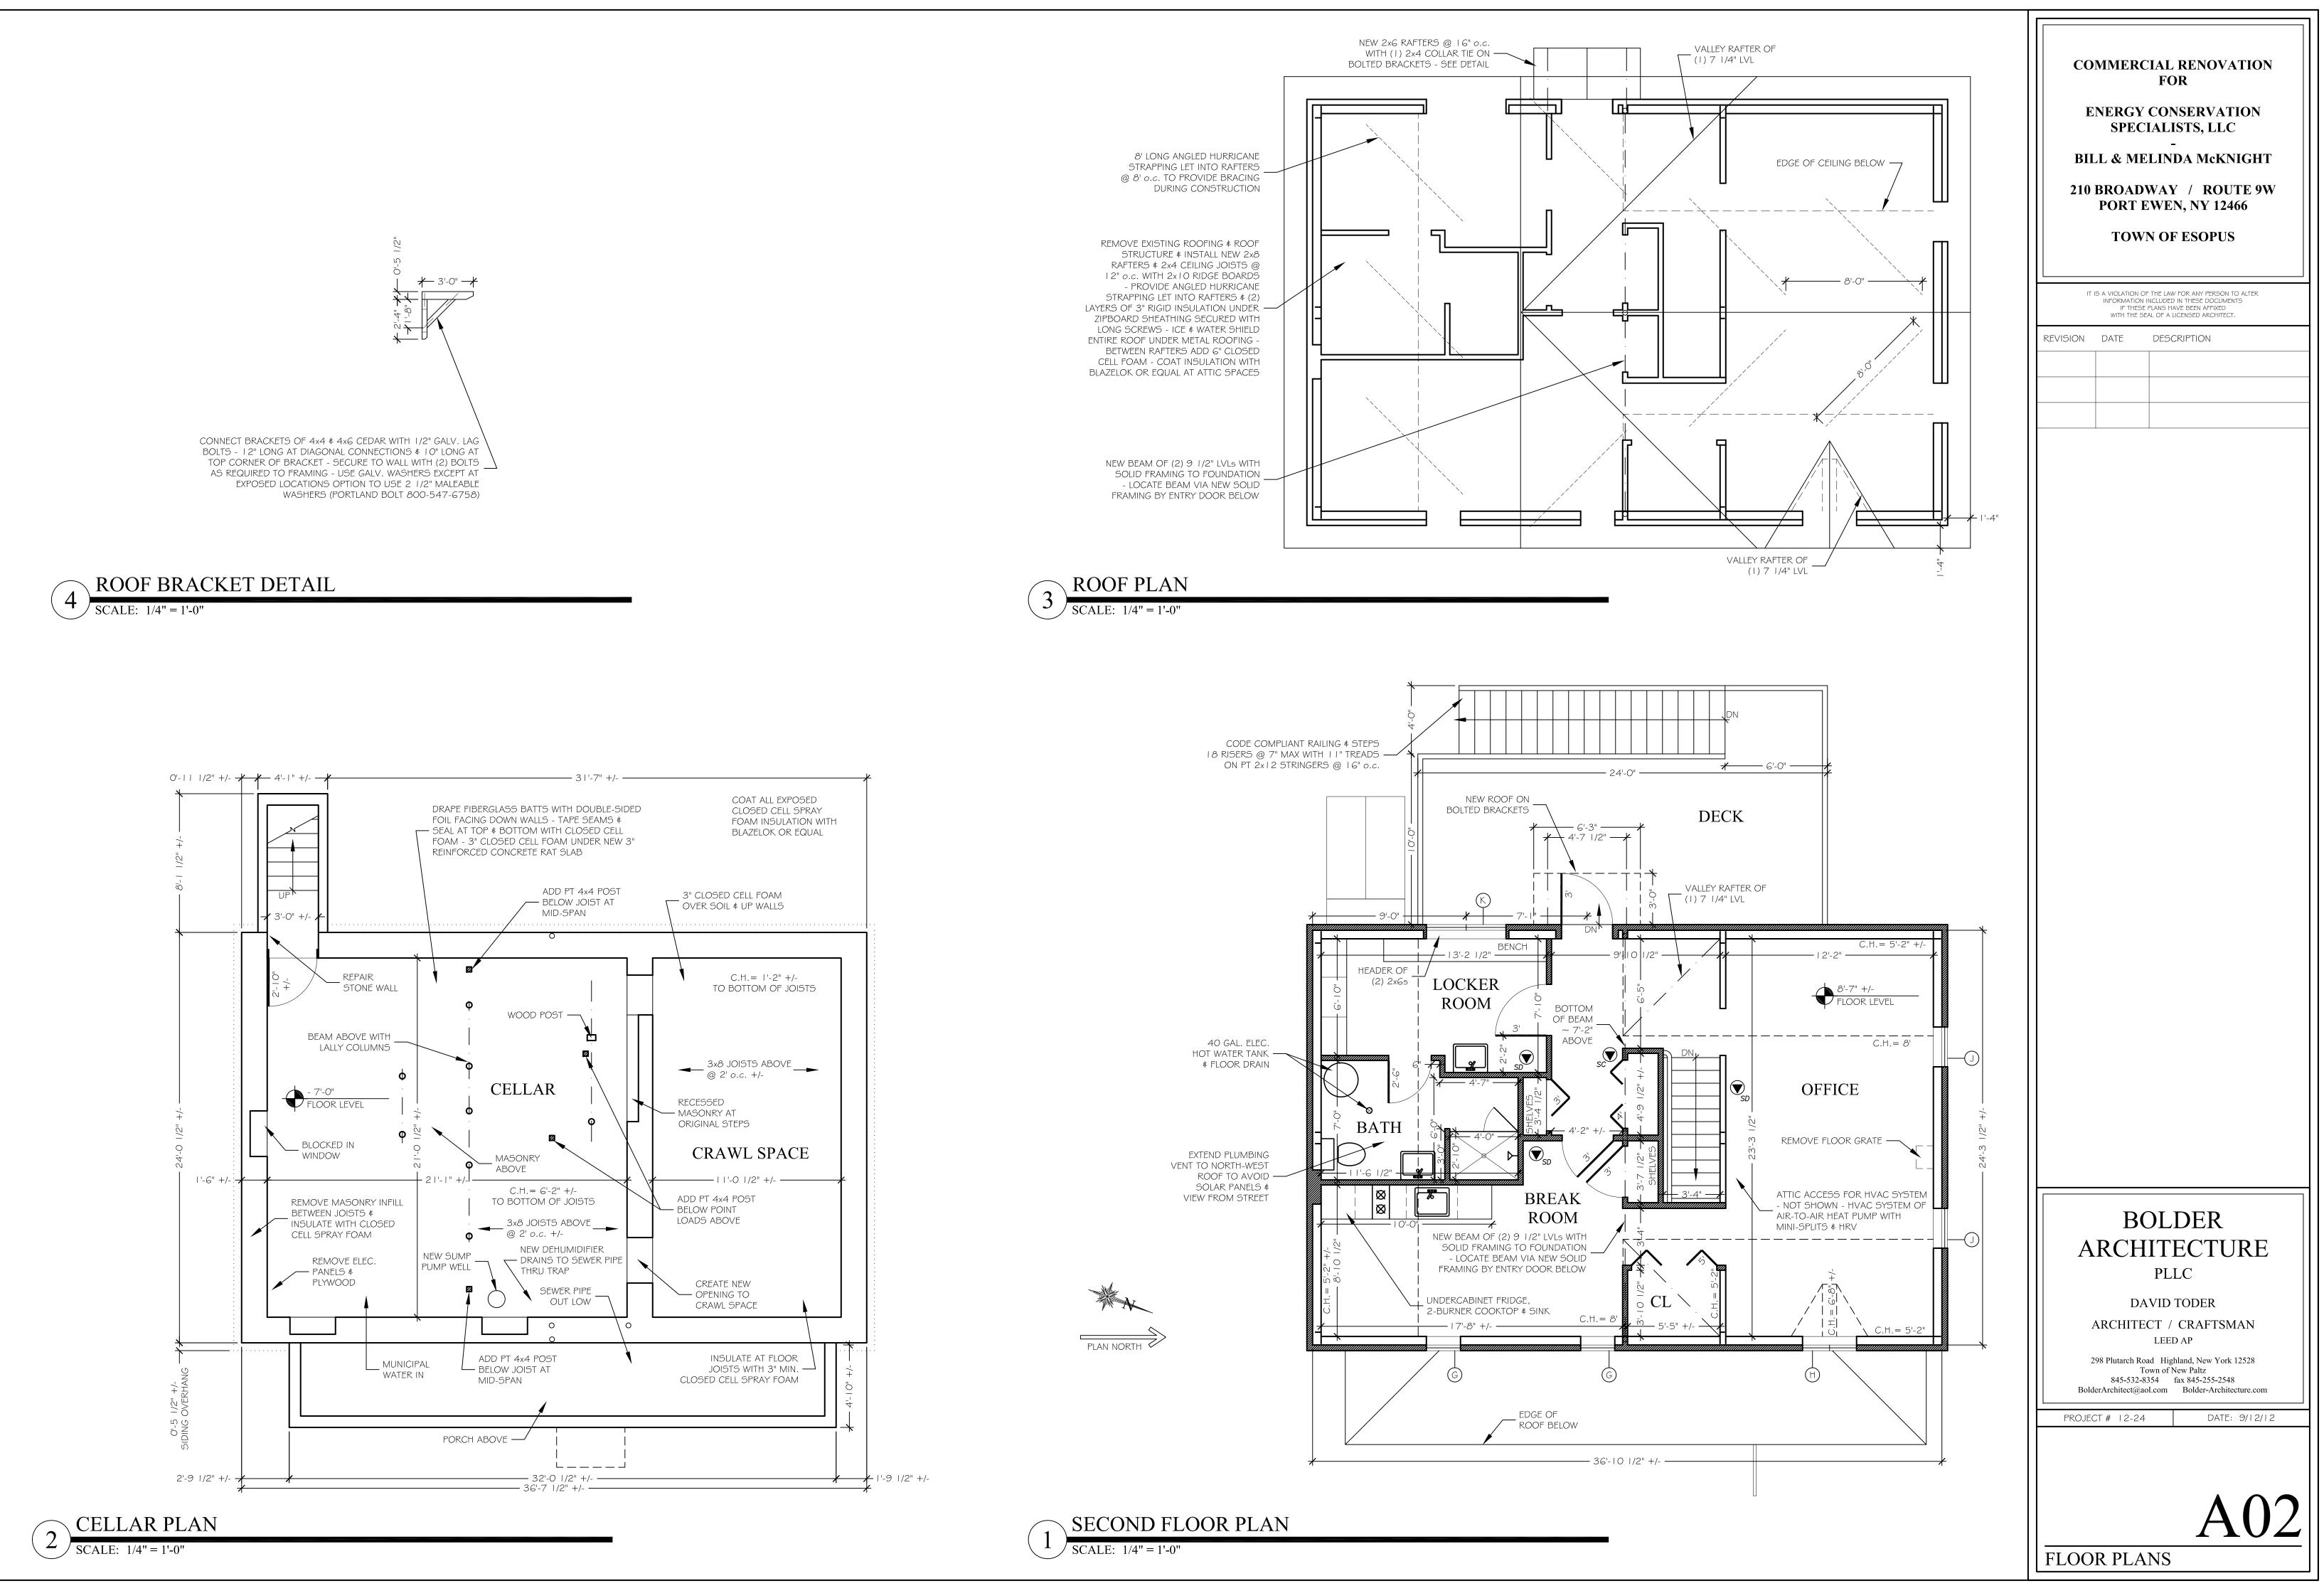


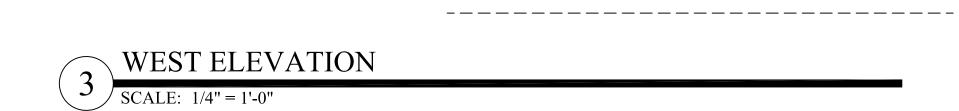


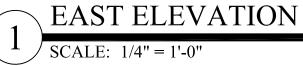


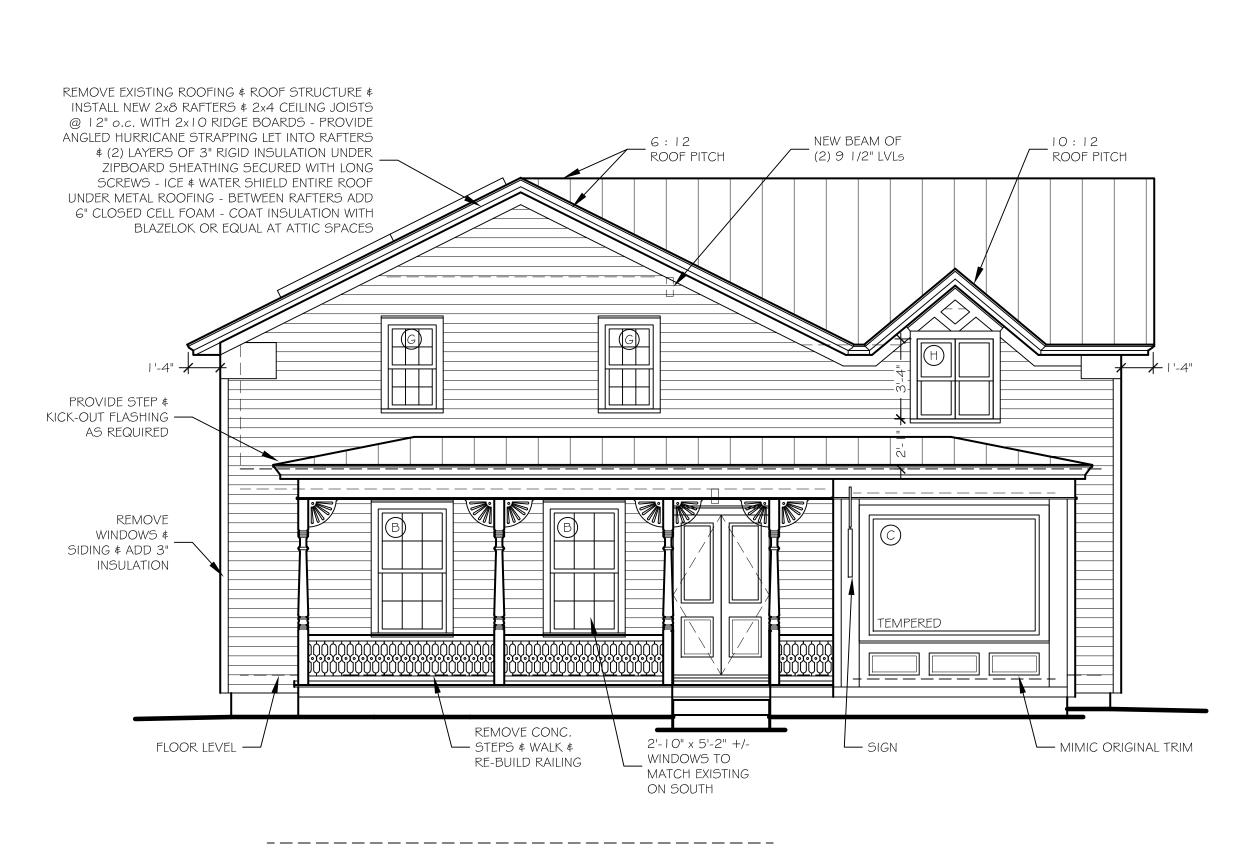




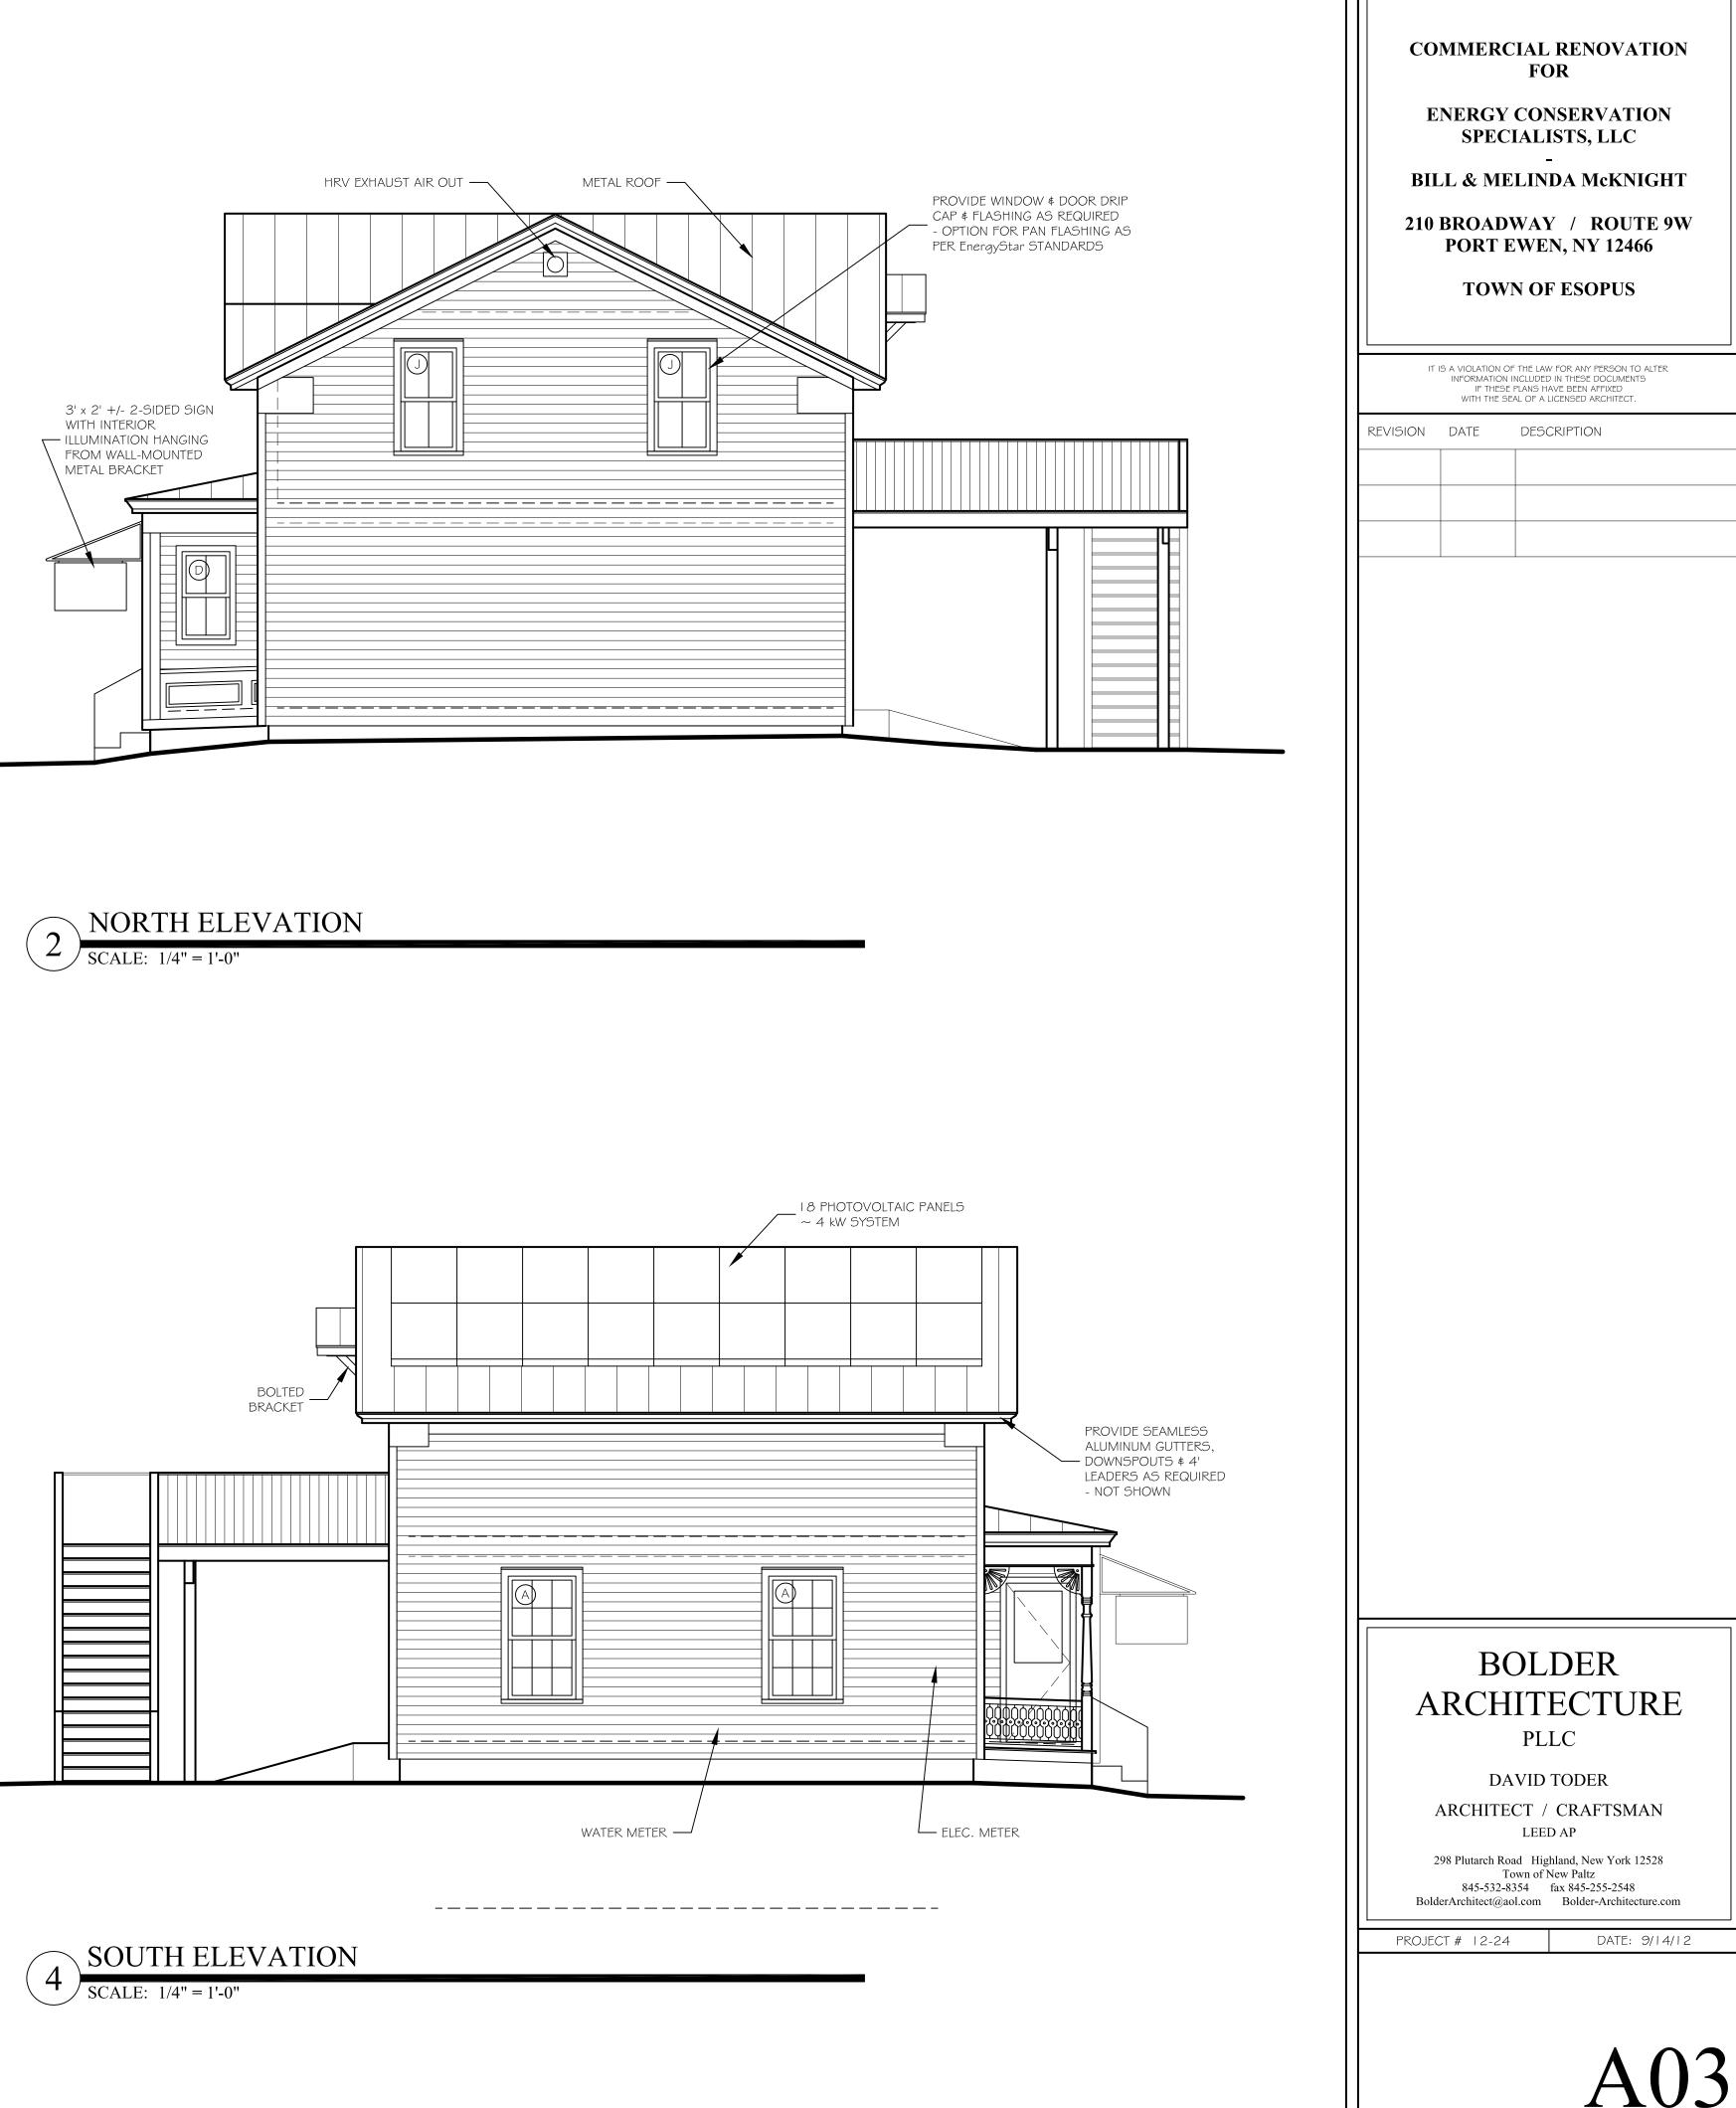

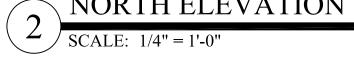

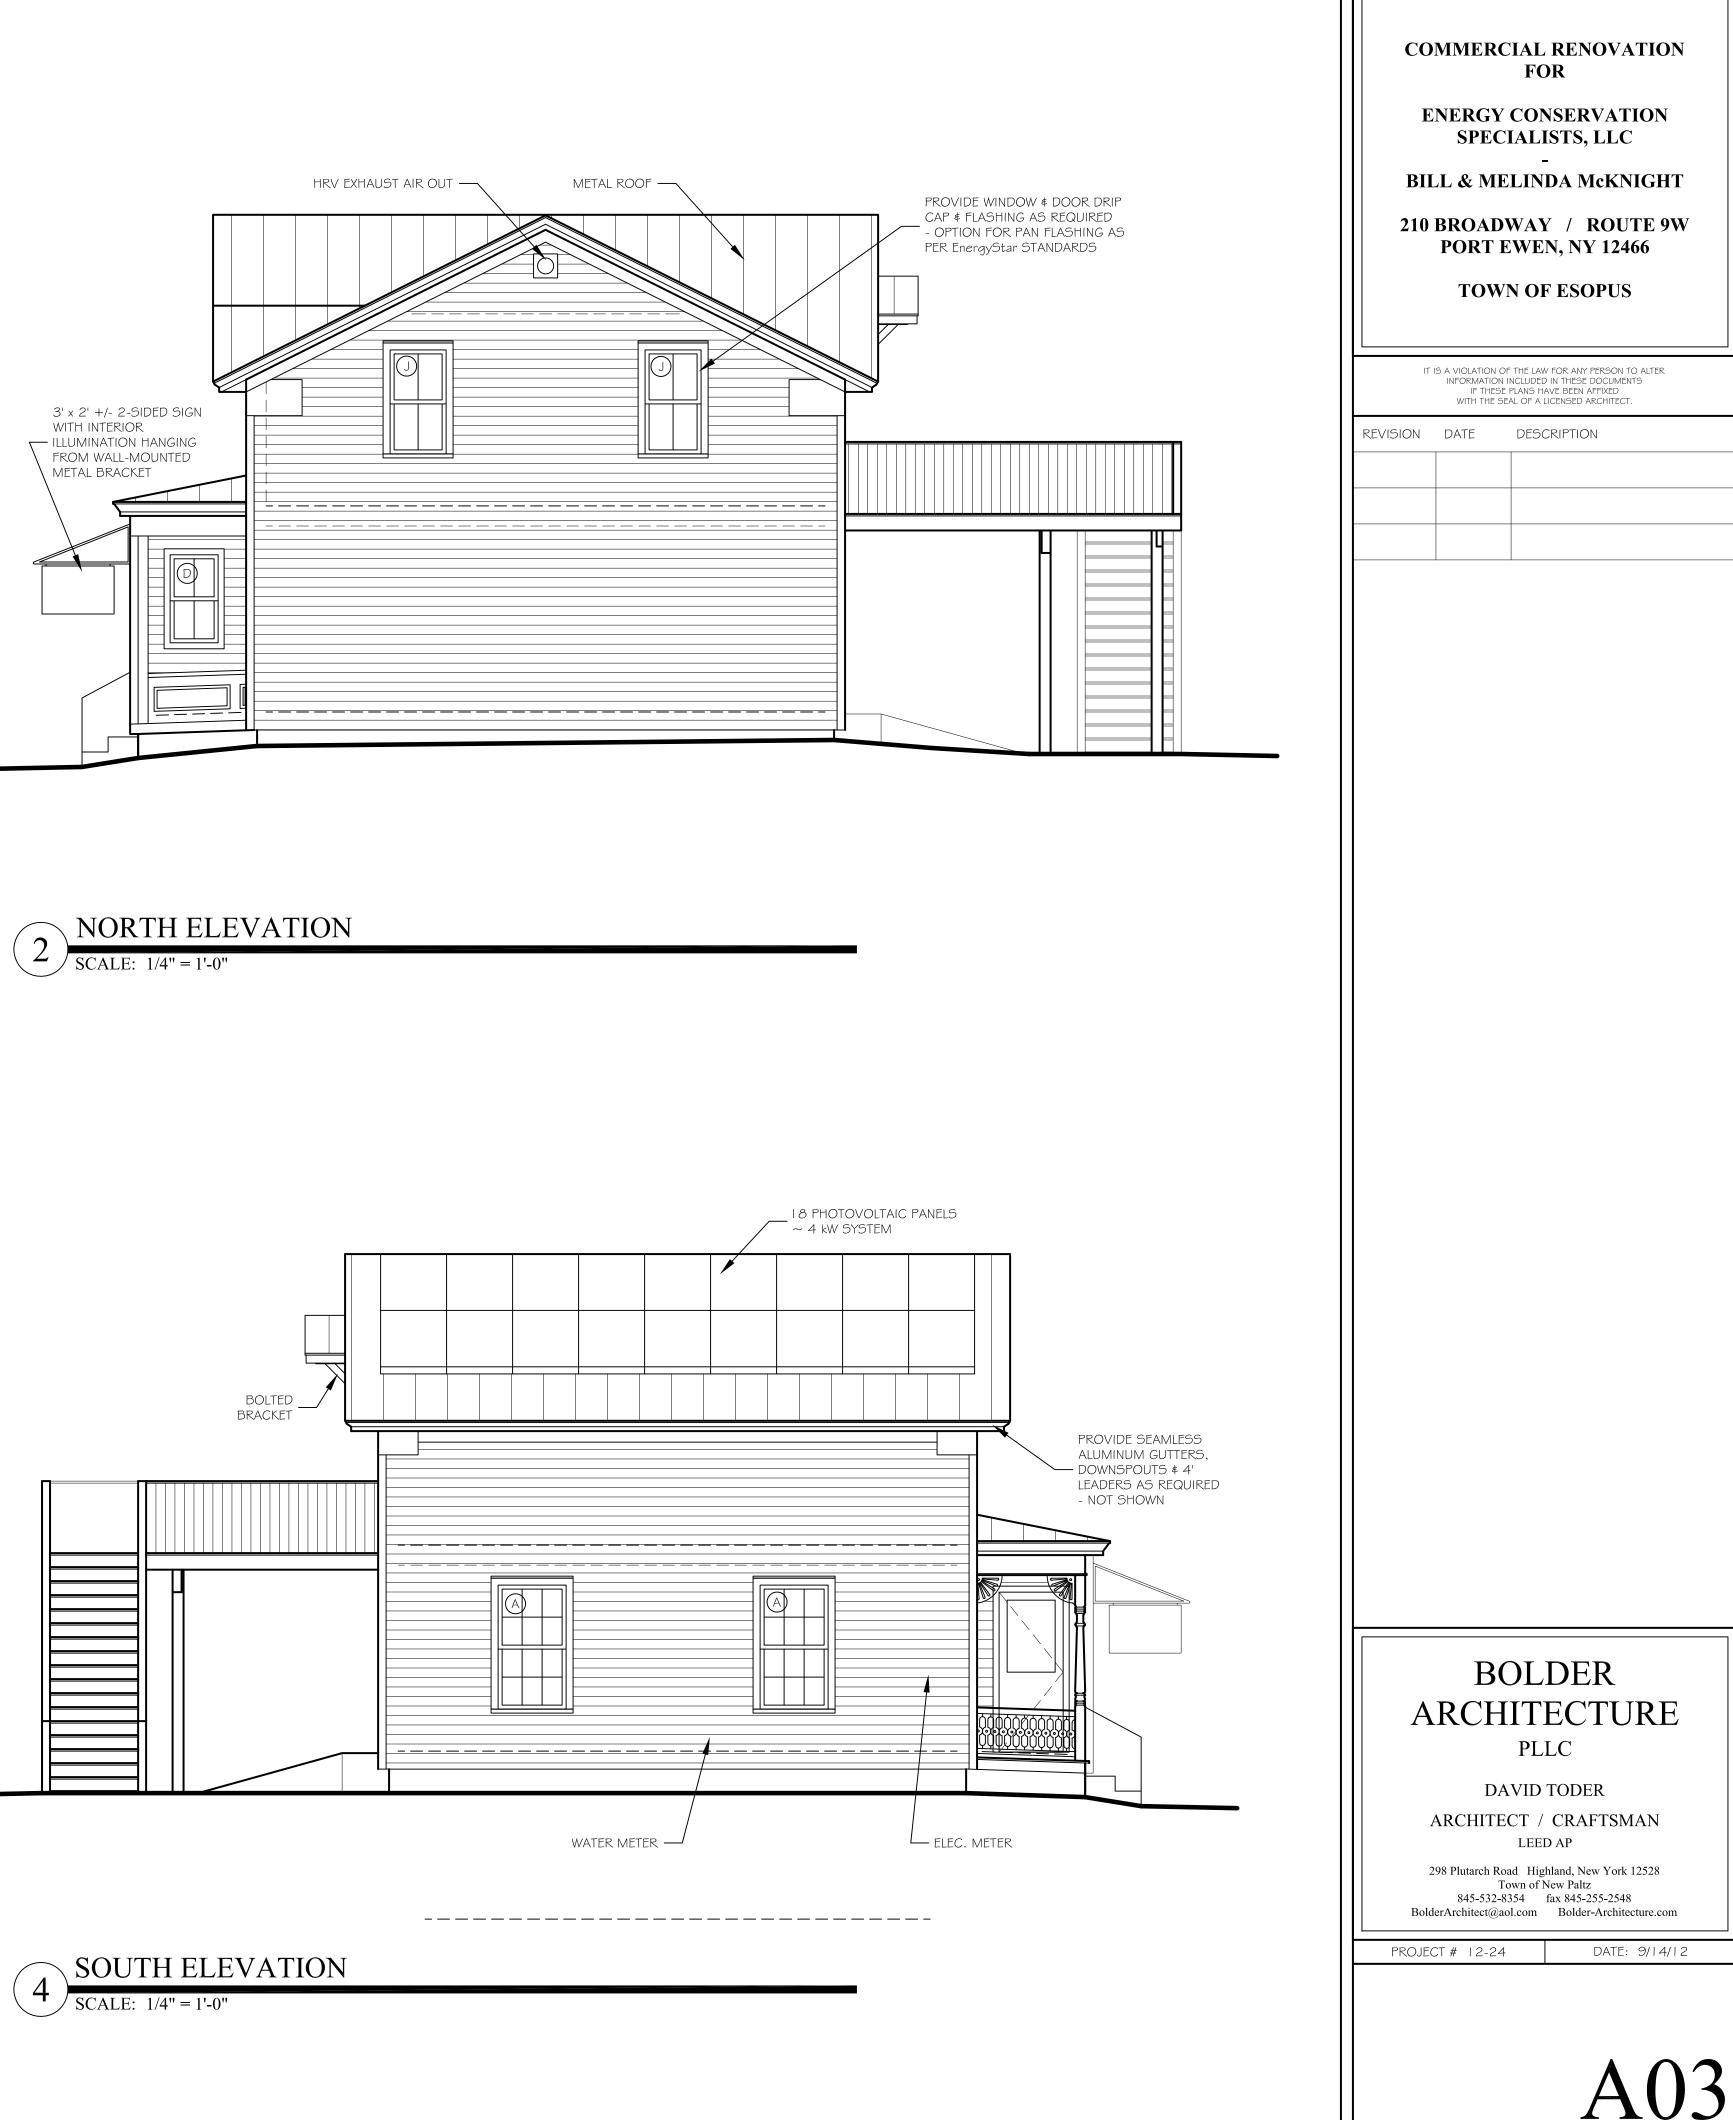

ELEVATIONS

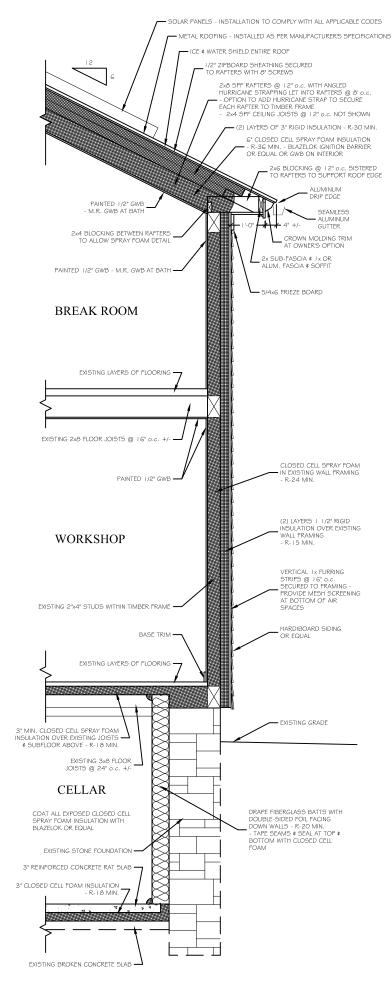

2) DETAILED WALL SECTION SCALE: 3/4" =1'-0"